


EXISTING NORTH ELEVATION

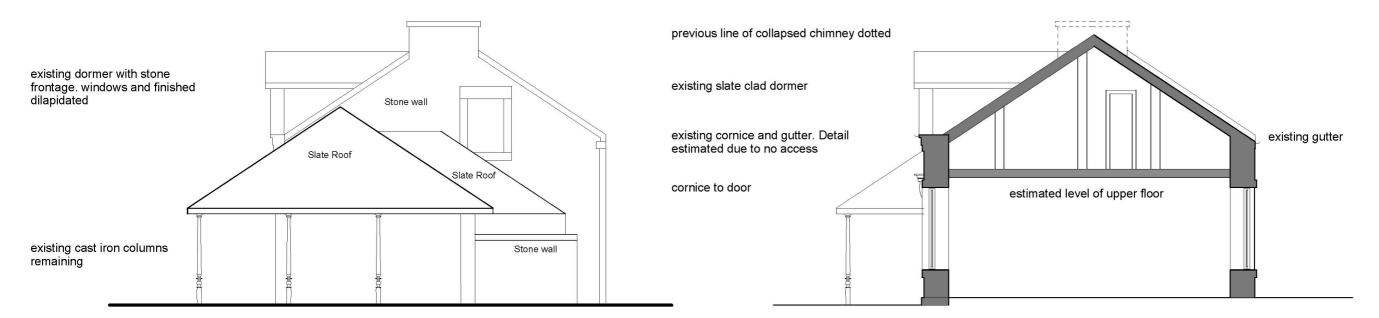

EXISTING EAST ELEVATION

GENERAL NOTES

Existing Farmhouse deemed Dangerous Building

All timber elements including roof, floors, wall linings have been exposed to long term water ingress and fire damage. All deemed to be unusable for use in an inhabitet structure and to be removed. Slates to be retained for re-use where possible dependant on slate condition.

Stonework to be surveyed prior to site start to assess extent of replacement/indenting. Stonework to be retained where strucurally sound.


Existing upper floors inaccessible due to flooring structural collapse.


no windows remaining in condition which would allow salvage.

Internal plasterwork and cornicework where reamining saturated beyond repair. No access to ground floor to fully assess due to structural instability above.

All shutters and existing security measures omitted for clarity


EXISTING SECTION A-A internal layout estimated as no access available - dangerous building

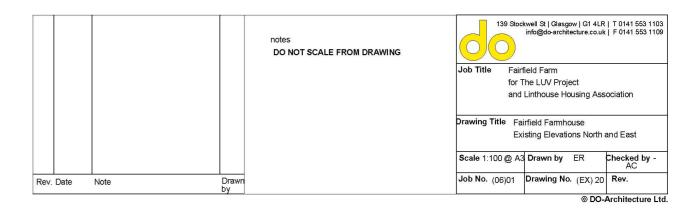

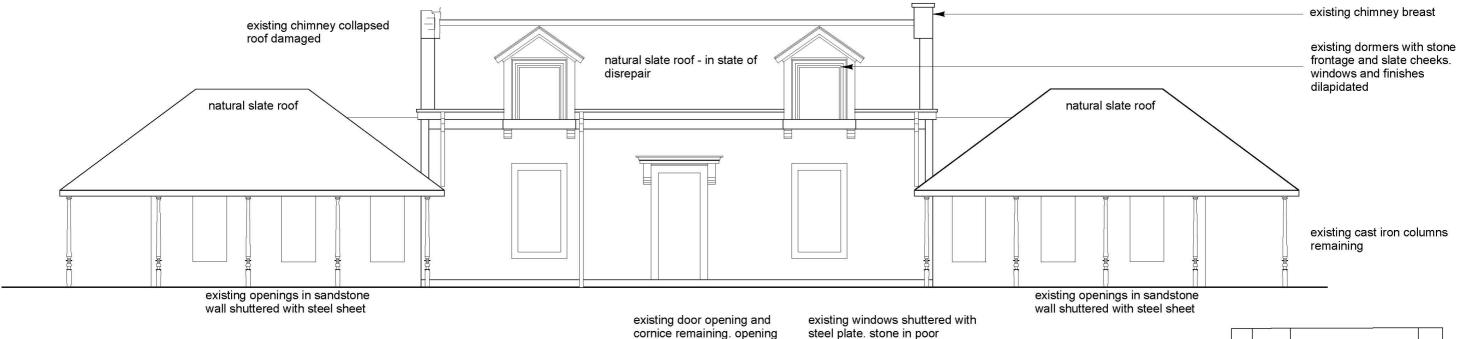

blocked up

EXISTING SOUTH ELEVATION

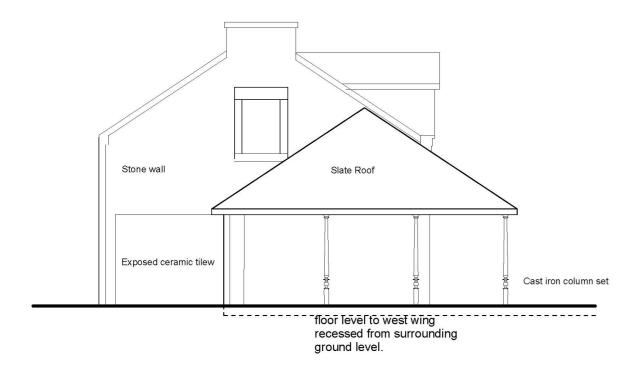

EXISTING WEST ELEVATION

GENERAL NOTES

condition

Existing Farmhouse deemed Dangerous Building

All timber elements including roof, floors, wall linings have been exposed to long term water ingress and fire damage. All deemed to be unusable for use in an inhabitet structure and to be removed. Slates to be retained for re-use where possible dependant on slate condition.


Stonework to be surveyed prior to site start to assess extent of replacement/indenting. Stonework to be retained where strucurally sound.

Existing upper floors inaccessible due to flooring structural collapse.

no windows remaining in condition which would allow salvage.

Internal plasterwork and cornicework where reamining saturated beyond repair. No access to ground floor to fully assess due to structural instability

All shutters and existing security measures omitted for clarity

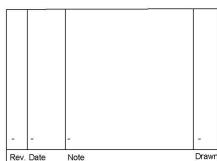

Note

DO NOT SCALE FROM DRAWING

All dimensions to be checked on site prior to the start of any work and any discrepancies notified in writing.

Refer to Engineers' drawings for all structural, heating, lighting, power, drainage and ventilation information

All building works to comply in all respects to current Building Standards for country in which site is located.

All electrical work to be carried out in accordance with the latest edition of the Institute of Electrical Engineers Regulations and to the approval of the Local Authority.

All drainage work to be carried out in consultation with the Local Authority Inspectors and to be tested to the satisfaction of the Local Authority.

Cast iron column set



Job Title

Fairfield Farm for The LUV Project and Linthouse Housing Association


Drawing Title Fairfield Farmhouse


Existing Elevation South and West

Scale 1:100 @ A3	Drawn by ER	Checked by -
Job No. (06)01	Drawing No.(EX) 21	Rev.


© DO-Architecture Ltd.

existing steel doors. original window opening cut down and widened to accomodate. part remaining over

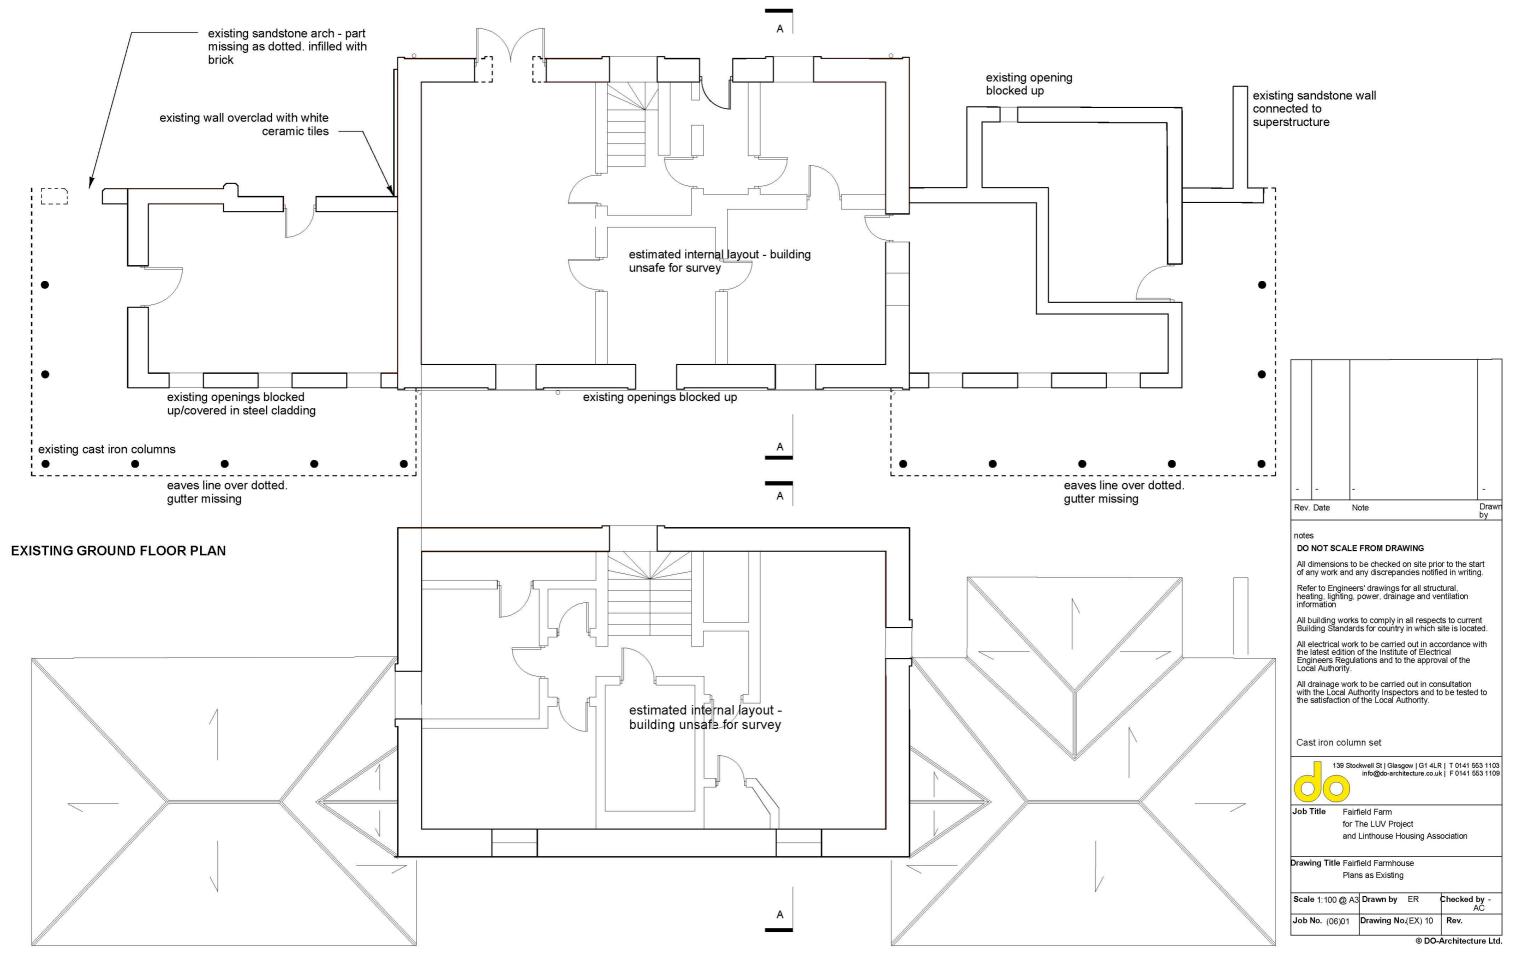

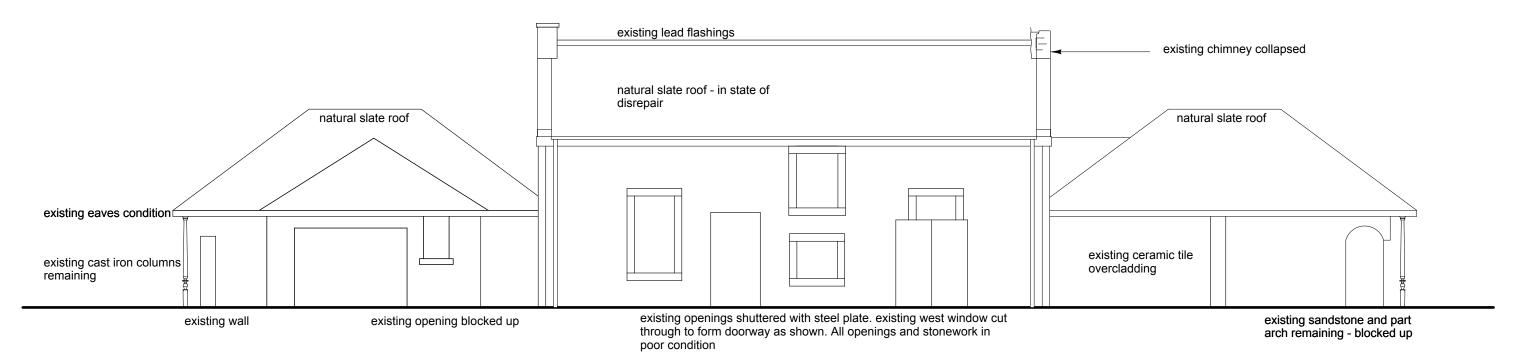

EXISTING NORTH ELEVATION

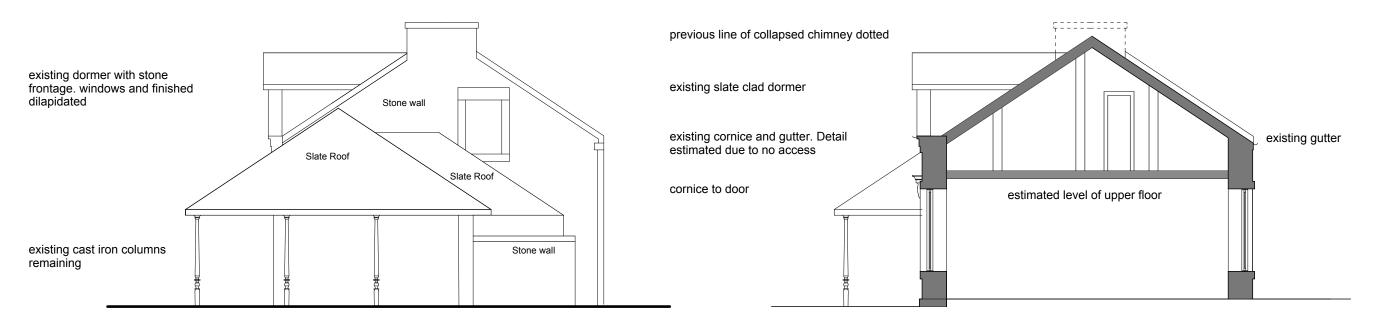

EXISTING EAST ELEVATION

GENERAL NOTES

Existing Farmhouse deemed Dangerous Building

All timber elements including roof, floors, wall linings have been exposed to long term water ingress and fire damage. All deemed to be unusable for use in an inhabitet structure and to be removed. Slates to be retained for re-use where possible dependant on slate condition.

Stonework to be surveyed prior to site start to assess extent of replacement/indenting. Stonework to be retained where strucurally sound.


Existing upper floors inaccessible due to flooring structural collapse.


no windows remaining in condition which would allow salvage.

Internal plasterwork and cornicework where reamining saturated beyond repair. No access to ground floor to fully assess due to structural instability above.

All shutters and existing security measures omitted for clarity


EXISTING SECTION A-A internal layout estimated as no access available - dangerous building

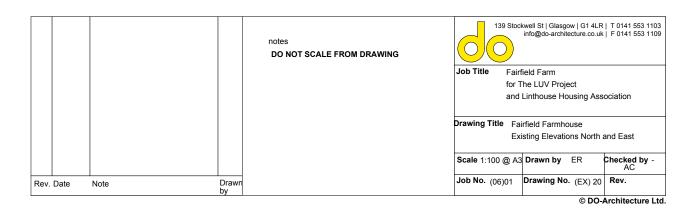

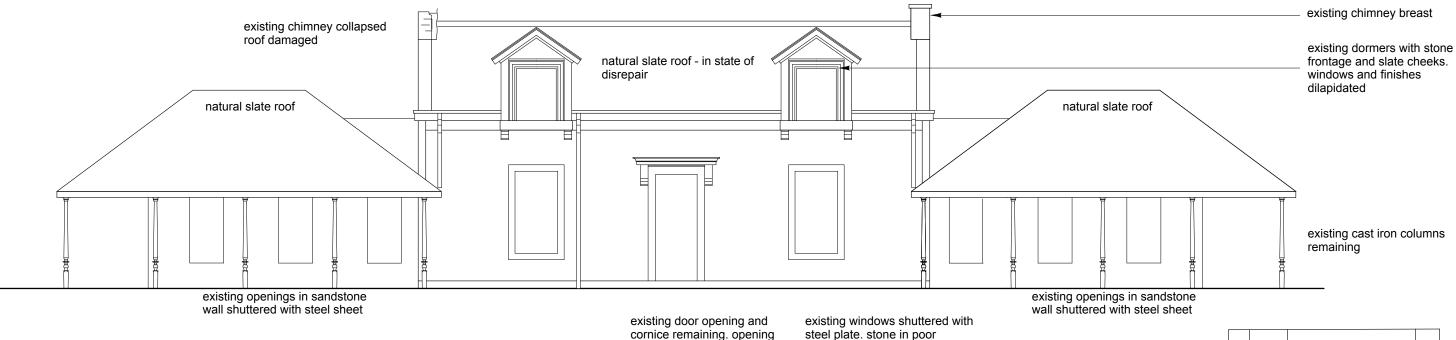

blocked up

EXISTING SOUTH ELEVATION

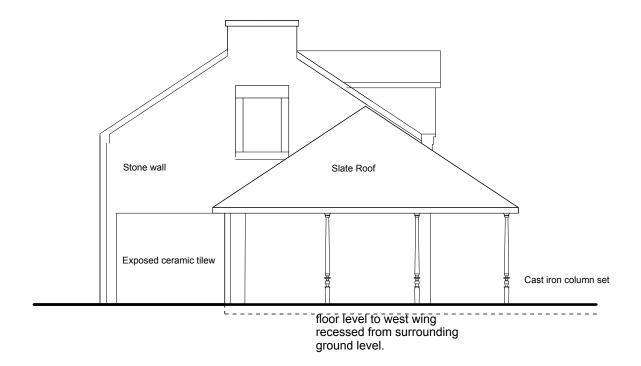

EXISTING WEST ELEVATION

GENERAL NOTES

condition

Existing Farmhouse deemed Dangerous Building

All timber elements including roof, floors, wall linings have been exposed to long term water ingress and fire damage. All deemed to be unusable for use in an inhabitet structure and to be removed. Slates to be retained for re-use where possible dependant on slate condition.


Stonework to be surveyed prior to site start to assess extent of replacement/indenting. Stonework to be retained where strucurally sound.

Existing upper floors inaccessible due to flooring structural collapse.

no windows remaining in condition which would allow salvage.

Internal plasterwork and cornicework where reamining saturated beyond repair. No access to ground floor to fully assess due to structural instability above.

All shutters and existing security measures omitted for clarity

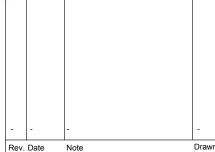

Rev. Date Note

notes

DO NOT SCALE FROM DRAWING

All dimensions to be checked on site prior to the start of any work and any discrepancies notified in writing.

Refer to Engineers' drawings for all structural, heating, lighting, power, drainage and ventilation information

All building works to comply in all respects to current Building Standards for country in which site is located.

All electrical work to be carried out in accordance with the latest edition of the Institute of Electrical Engineers Regulations and to the approval of the Local Authority.

All drainage work to be carried out in consultation with the Local Authority Inspectors and to be tested to the satisfaction of the Local Authority.

Cast iron column set



139 Stockwell St | Glasgow | G1 4LR | T 0141 553 1103 info@do-architecture.co.uk | F 0141 553 1109

Job Title

Fairfield Farm for The LUV Project and Linthouse Housing Association


Drawing Title Fairfield Farmhouse


Existing Elevation South and West

Scale 1:100 @ A3	Drawn by ER	Checked by AC
Job No. (06)01	Drawing No.(EX) 21	Rev.

© DO-Architecture Ltd.


existing steel doors. original window opening cut down and widened to accomodate. part remaining over

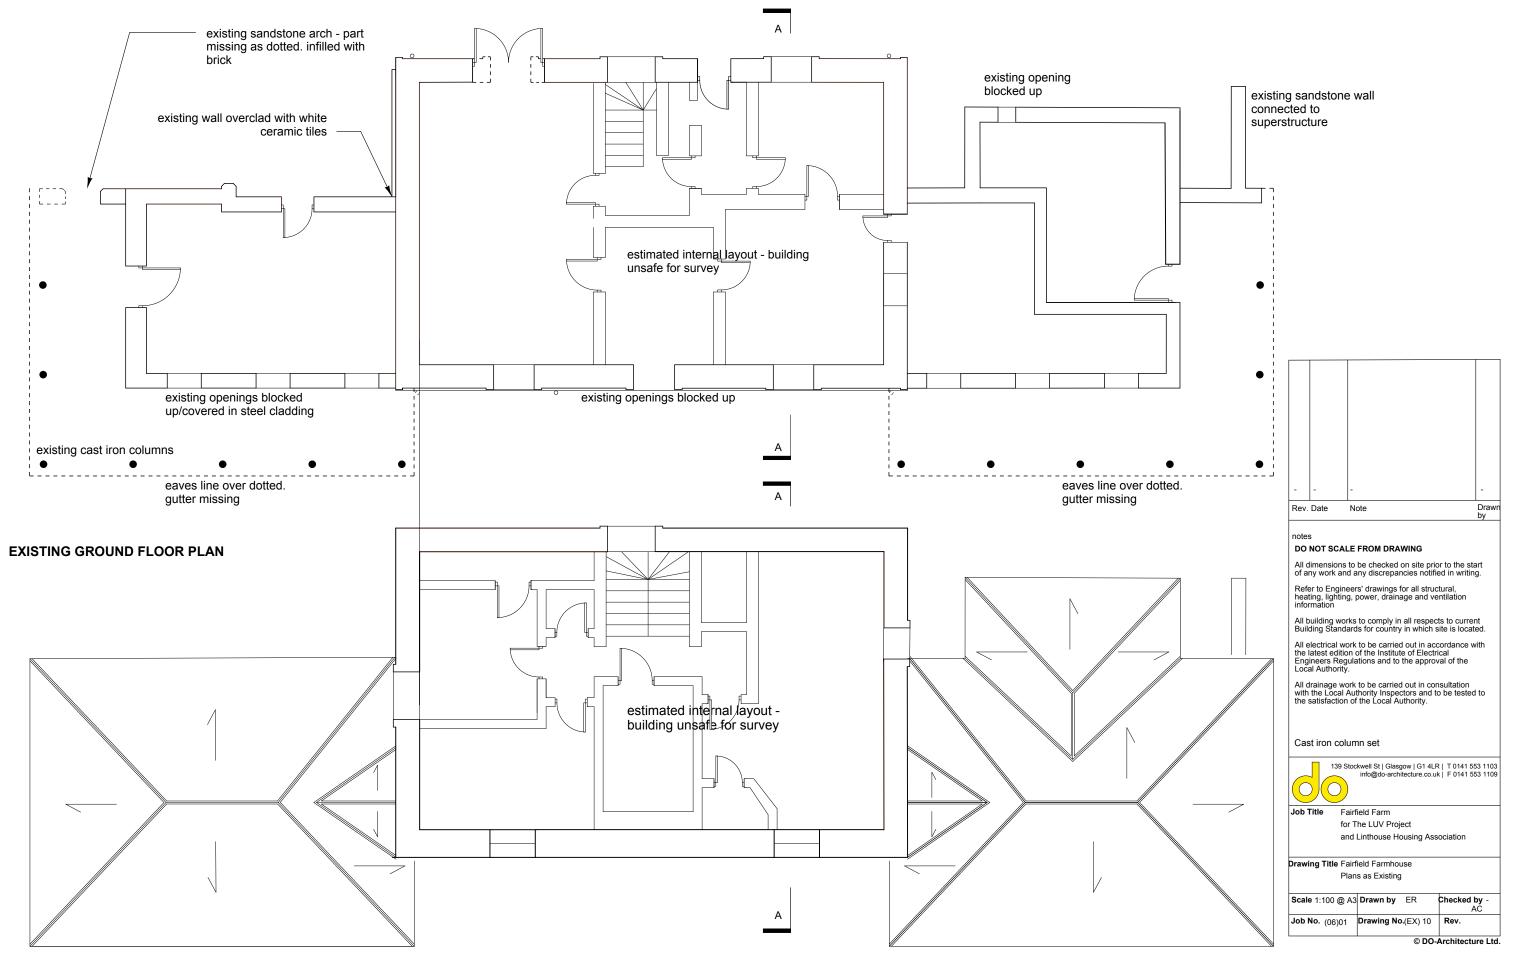


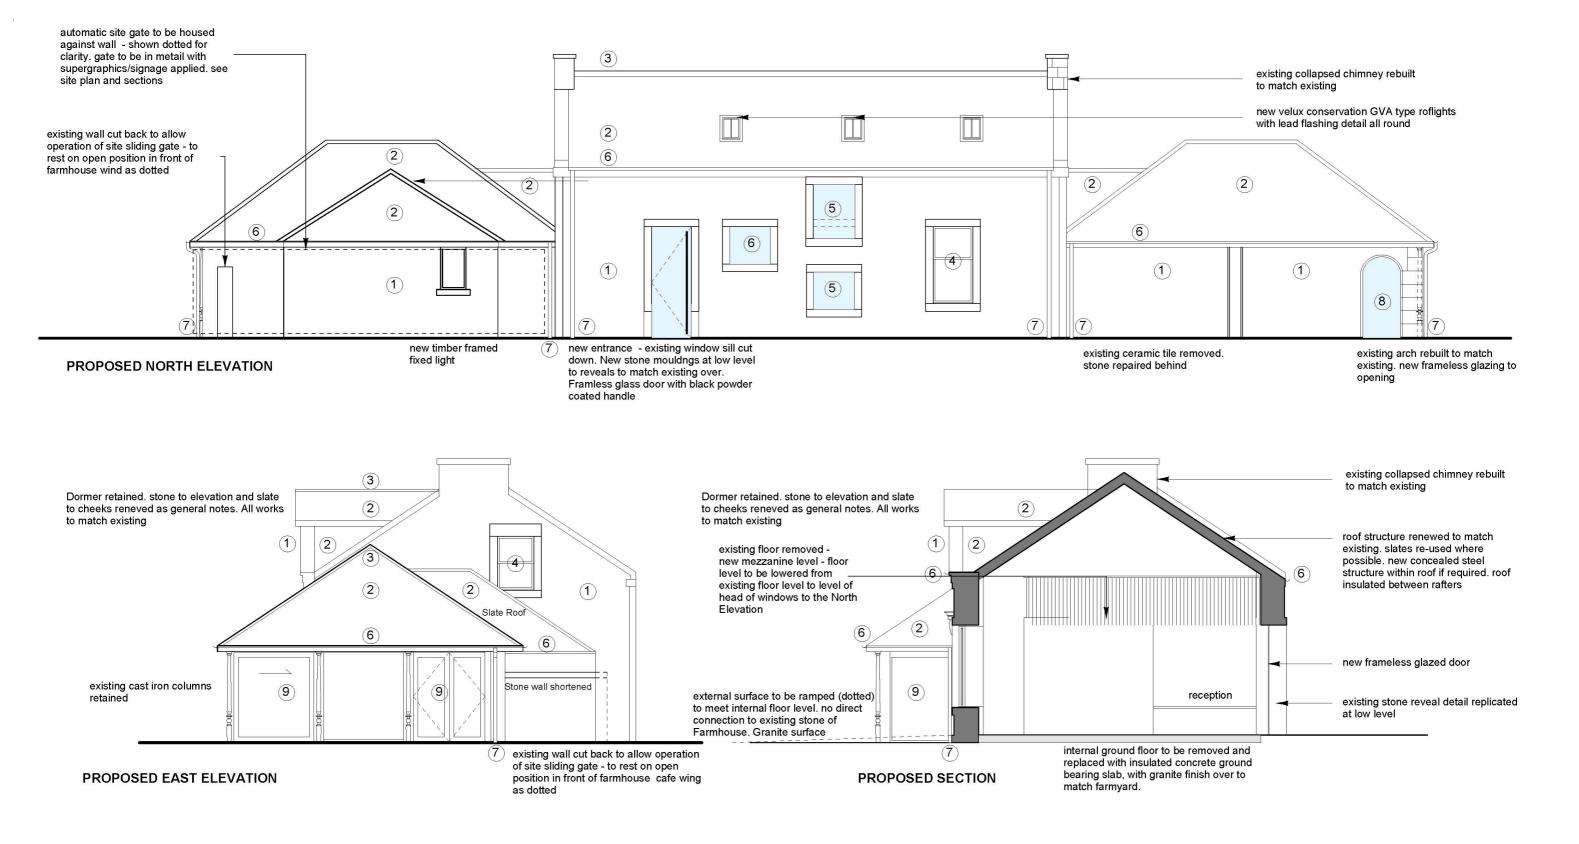

LEGEND

- Existing/repaired sandstone
- Re-used/new slate to match existing
- 3. New Code 4 lead flashings
- New painted timber sliding sash and case windows in existing openings. internal sliding timber shutters
- Frameless glazing in existing opening 5.
- Frameless glazing in new opening with sandstone detailing to reveals to match existing
- 6.
- 6. Cast iron Ogee gutter Cast iron downpipes
- existing arch rebuilt in sandstone to match existing- frameless glass double glazed window fitted to arch
- New glazing to wings timber framed ebonised double glazed units with sliding sections. High quality Stainless steel woven mesh security shutters to be installed above eaves level in front of glazing for use when building is not operational

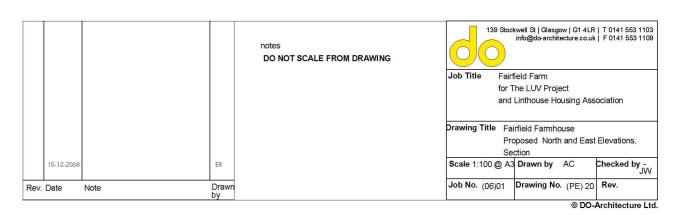

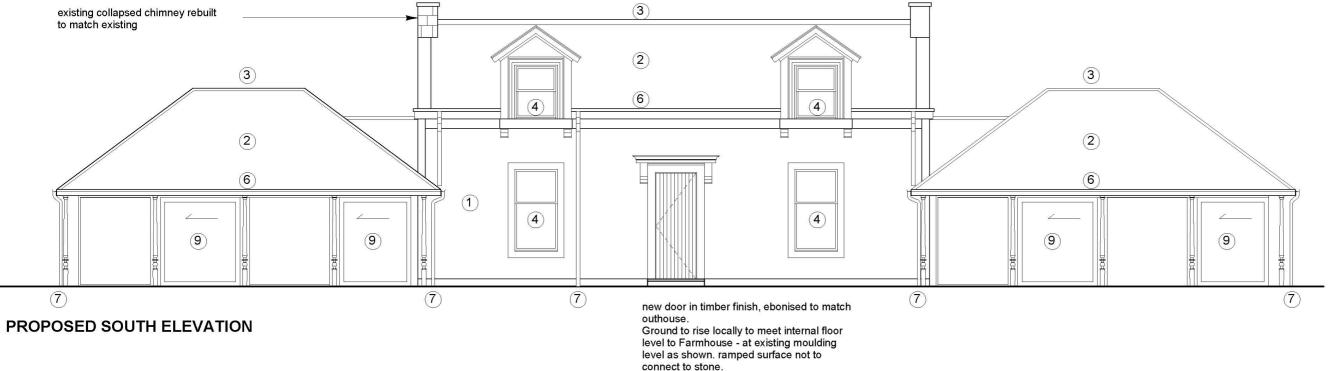

WORKS TO EXISTING FARMHOUSE - GENERAL NOTES

All timber and internal fittings and finishes are beyond salvage and are to be removed due to water ingress and fire damage. Existing stone shell to be retained.

Stone to be surveyed prior to construction to assess extent of stone replacement/indents. New stone to be matched to existing stone to Planning Departments satisfaction. Existing cement based mortar to be hacked out and replaced with lime mortar. Scottish lime centre to be consulted to confirm appropriate mortar match for replacement.

Existing slate to be removed and retained where possible for re-use. New slate to be matched to existing to the satisfaction of the Planning Department. Salvaged Scots slate to be used if matching and available.

Unless noted otherwise on the elevations, New windows to existing stone openings within the existing farmhouse building to be timber sliding sash double glazed units, paint finish.

Existing Cast iron Columns to be removed from site, tested and treated (paint to be removed by shot firing, cast iron to receive preservative paint treatment), then reinstalled on site on new foundations. New eaves beam to be installed over to carry new roof structure.

New steel structure to be installed, concealed behind linings to stabilise existing stone structure. New roof structure to be timber. Roof structure to wings to be installed on existing repaired columns, structure to allow for open void to ridge line - no timber ties at eaves level.

All new rainwater goods to be in cast iron. Ogee gutters to be used, painted black. Cast iron round downpipes.


All windows to Farmhouse to have internal or external shutters for security purposes. Existing window openings to Farmhouse to have internal lockable timber shutters. Door to rear of Farmhouse to have internal electronic security shutter. Windows to both wings to be set back to allow installation of stainless steel woven mesh electronic shutters externally, fixed above line of existing eaves fascia board. Shutters to close behind line of existing columns. Rails to shutters to be in black powder coated steel fixed to black window frames.

Existing floor to farmhouse to be grubbed up to allow for strucrural works. New insulated concrete floor installed with granite finish to match farmyard finish. Floor to have recesses with glazed cover (as floor finish) to allow display of artefacts from Glasgow City Council Open Museum relating to Govans History

All external walls to Farmhouse to be insulated with insulated plasterboard - required under building regulations. Plasterboard to conceal any structural ties required to stabilise existing stone structure

LEGEND


- Existing/repaired sandstone
- Re-used/new slate to match existing
- New Code 4 lead flashings 3
- New painted timber sliding sash and case windows in existing openings, internal sliding timber shutters
- Frameless glazing in existing opening
- Frameless glazing in new opening with sandstone detailing to reveals to match existing
- Cast iron Ogee gutter Cast iron downpipes
- existing arch rebuilt in sandstone to match existing- frameless glass double glazed window fitted to arch
- New glazing to wings timber framed ebonised double glazed units with sliding sections. High quality Stainless steel woven mesh security shutters to be installed above eaves level in front of glazing for use when building is not operational

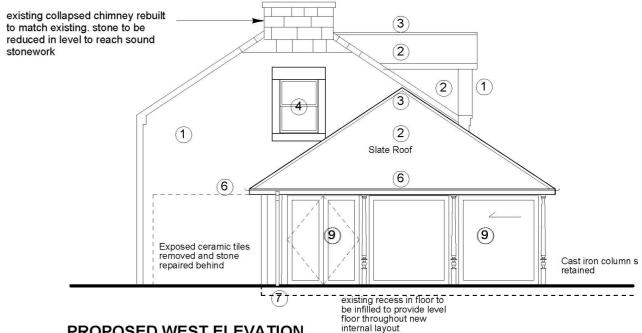


PROPOSED WEST ELEVATION

139 Stockwell St | Glasgow | G1 4LR | T 0141 553 1103 info@do-architecture.co.uk | F 0141 553 1109 DO NOT SCALE FROM DRAWING Job Title Fairfield Farm for The LUV Project and Linthouse Housing Association Drawing Title Fairfield Farmhouse Proposed South and West Elevations Checked by -Scale 1:100 @ A3 Drawn by Job No. (06)01 Drawing No. (PE) 21 Rev. Date Drawn


@ DO-Architecture I to

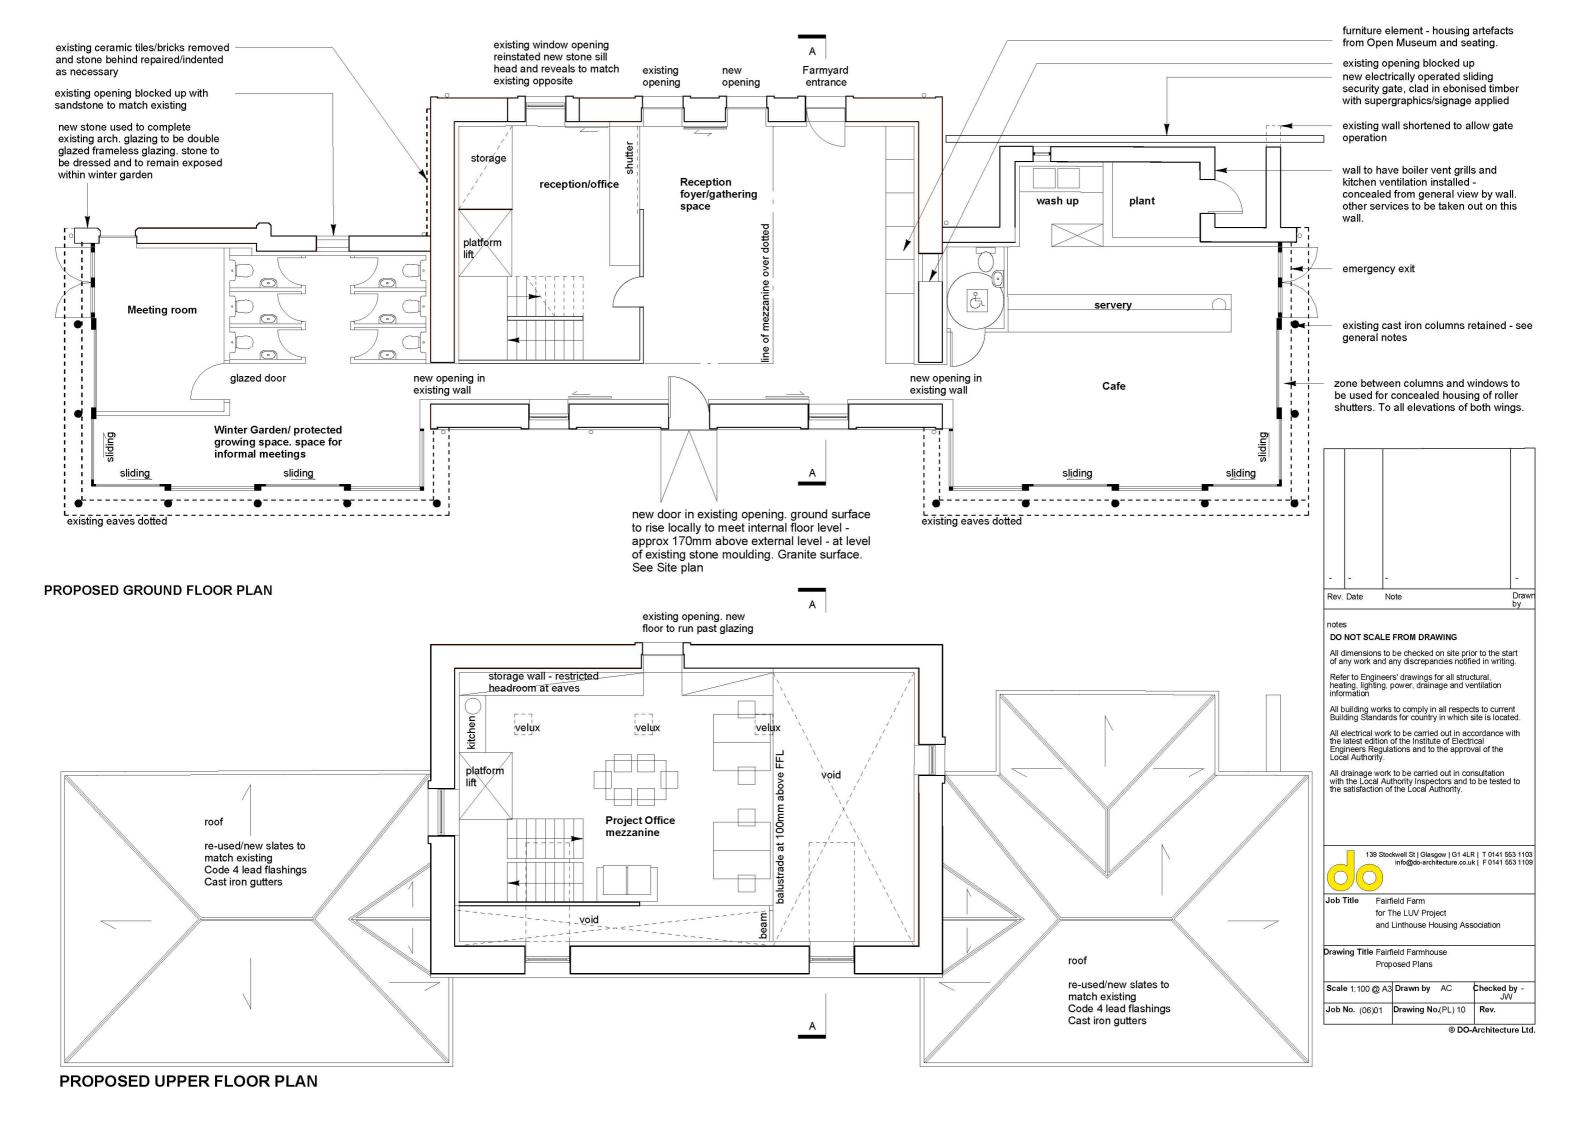


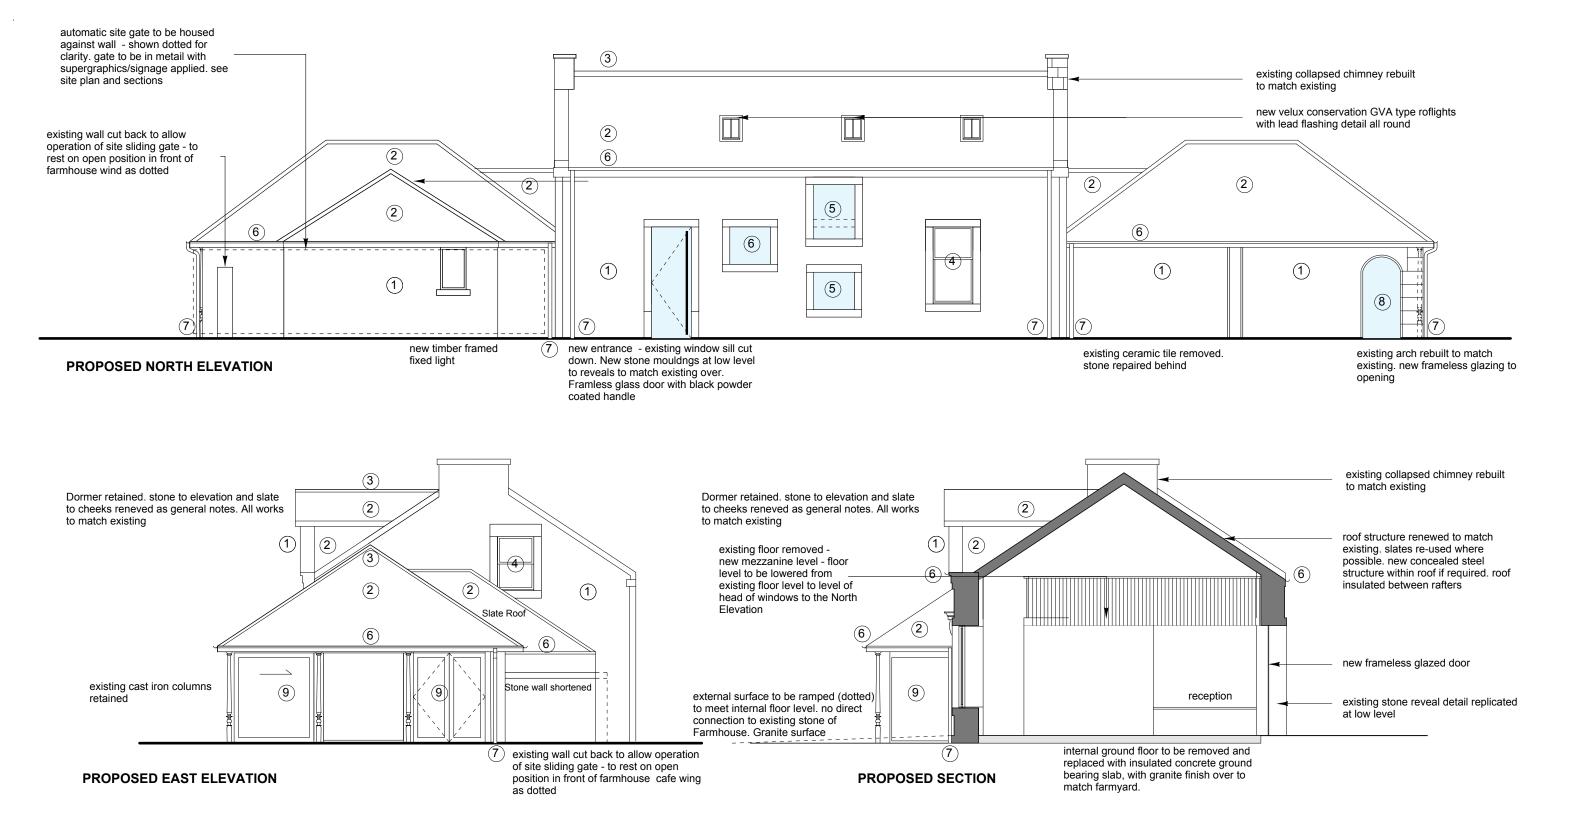

LEGEND

- 1. Existing/repaired sandstone
- 2. Re-used/new slate to match existing
- 3. New Code 4 lead flashings
- 4. New painted timber sliding sash and case windows in existing openings. internal sliding timber shutters
- 5. Frameless glazing in existing opening
- 6. Frameless glazing in new opening with sandstone detailing to reveals to match existing
- 6. Cast iron Ogee gutter
- Cast iron downpipes
- 8. existing arch rebuilt in sandstone to match existing- frameless glass double glazed window fitted to arch
- New glazing to wings timber framed ebonised double glazed units with sliding sections. High quality Stainless steel
 woven mesh security shutters to be installed above eaves level in front of glazing for use when building is not
 operational

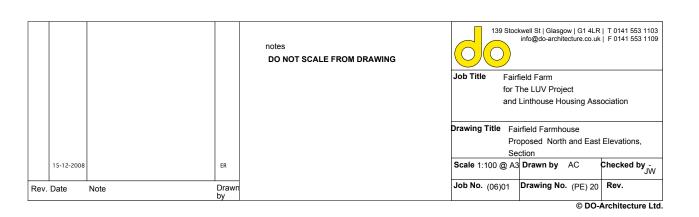

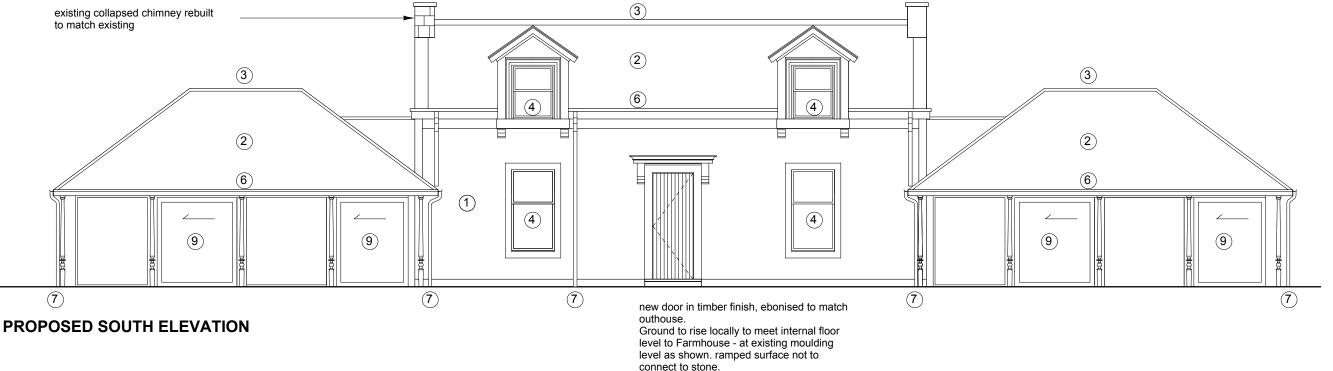

WORKS TO EXISTING FARMHOUSE - GENERAL NOTES

All timber and internal fittings and finishes are beyond salvage and are to be removed due to water ingress and fire damage. Existing stone shell to be retained.

Stone to be surveyed prior to construction to assess extent of stone replacement/indents. New stone to be matched to existing stone to Planning Departments satisfaction. Existing cement based mortar to be hacked out and replaced with lime mortar. Scottish lime centre to be consulted to confirm appropriate mortar match for replacement.

Existing slate to be removed and retained where possible for re-use. New slate to be matched to existing to the satisfaction of the Planning Department. Salvaged Scots slate to be used if matching and available.

Unless noted otherwise on the elevations, New windows to existing stone openings within the existing farmhouse building to be timber sliding sash double glazed units, paint finish.

Existing Cast iron Columns to be removed from site, tested and treated (paint to be removed by shot firing, cast iron to receive preservative paint treatment), then reinstalled on site on new foundations. New eaves beam to be installed over to carry new roof structure.

New steel structure to be installed, concealed behind linings to stabilise existing stone structure. New roof structure to be timber. Roof structure to wings to be installed on existing repaired columns. structure to allow for open void to ridge line - no timber ties at eaves level.

All new rainwater goods to be in cast iron. Ogee gutters to be used, painted black. Cast iron round downpipes.


All windows to Farmhouse to have internal or external shutters for security purposes. Existing window openings to Farmhouse to have internal lockable timber shutters. Door to rear of Farmhouse to have internal electronic security shutter. Windows to both wings to be set back to allow installation of stainless steel woven mesh electronic shutters externally, fixed above line of existing eaves fascia board. Shutters to close behind line of existing columns. Rails to shutters to be in black powder coated steel fixed to black window frames.


Existing floor to farmhouse to be grubbed up to allow for strucrural works. New insulated concrete floor installed with granite finish to match farmyard finish. Floor to have recesses with glazed cover (as floor finish) to allow display of artefacts from Glasgow City Council Open Museum relating to Govans History

All external walls to Farmhouse to be insulated with insulated plasterboard - required under building regulations. Plasterboard to conceal any structural ties required to stabilise existing stone structure

LEGEND

- 1. Existing/repaired sandstone
- 2. Re-used/new slate to match existing
- 3. New Code 4 lead flashings
- 4. New painted timber sliding sash and case windows in existing openings. internal sliding timber shutters
- 5. Frameless glazing in existing opening
- 6. Frameless glazing in new opening with sandstone detailing to reveals to match existing
- 6. Cast iron Ogee gutter
- 7. Cast iron downpipes
- 8. existing arch rebuilt in sandstone to match existing- frameless glass double glazed window fitted to arch
- New glazing to wings timber framed ebonised double glazed units with sliding sections. High quality Stainless steel
 woven mesh security shutters to be installed above eaves level in front of glazing for use when building is not
 operational

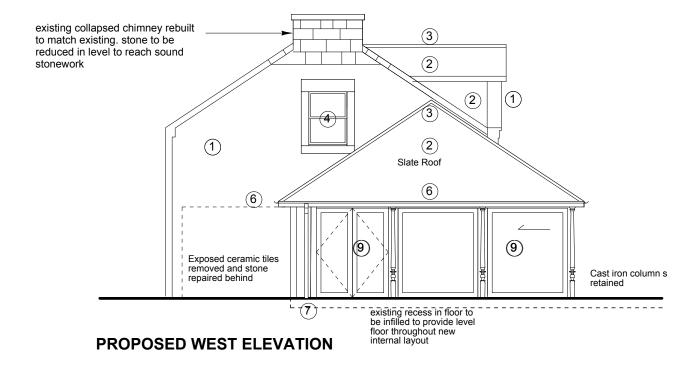

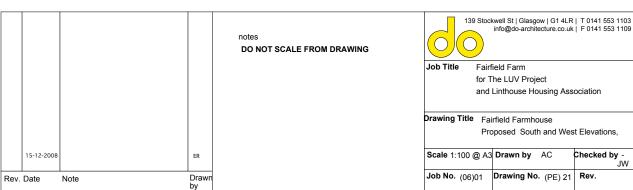

© DO-Architecture Ltd.

